


SITE PLAN CONTENT:

- NORTH ARROW
- SCALE
- FRONTAGE AND SIDE STREETS
- LOCATION OF IMPERVIOUS STRUCTURES AND IMPERVIOUS SURFACES
- EXISTING VEGETATION
- LAND SLOPE DIRECTION
- NEARBY STORM DRAIN/INLETS
- LOCATION OF NEARBY WATERWAYS OR BASINS
- ALL BEST MANAGEMENT PRACTICES TO BE PLACED ON AND OFF-SITE

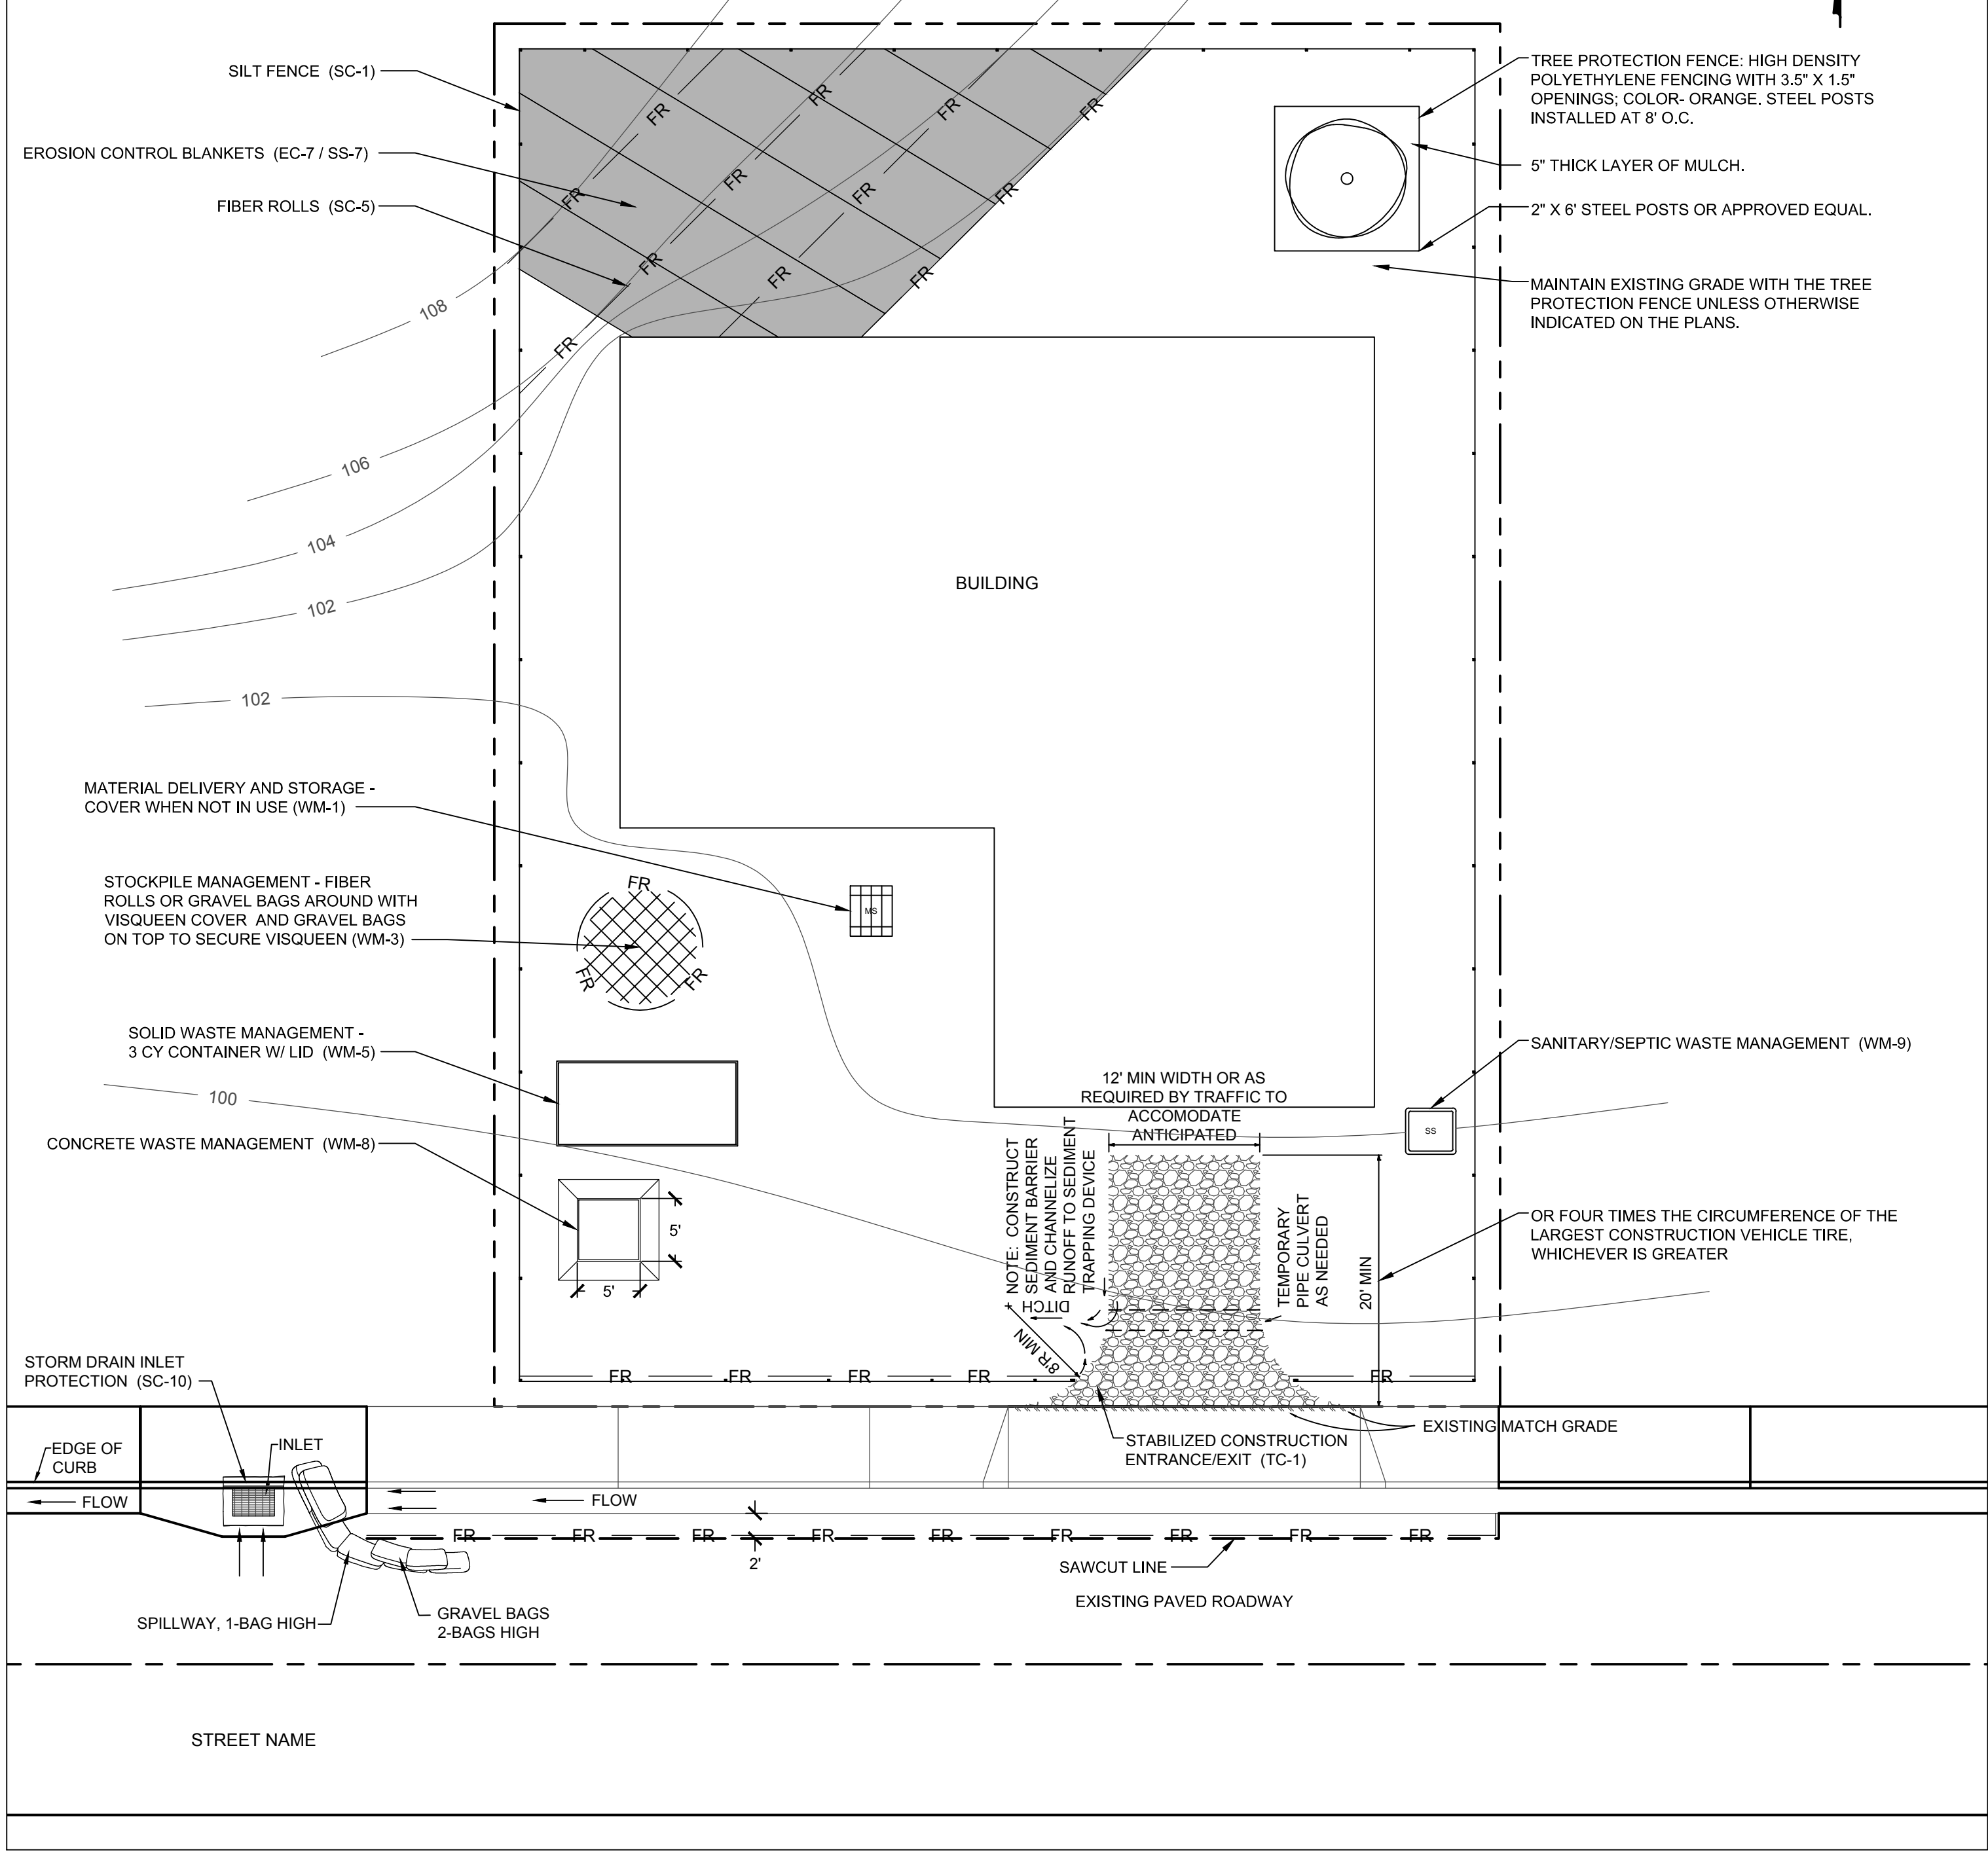

LEGEND

612	STREET ADDRESS NUMBER
001-184-014	ASSESSOR'S PARCEL NUMBER
o	(E) RIGHT OF WAY MONUMENT
△	CONTROL POINT
X 161.68	SPOT ELEVATION
○	TREE
○	MANHOLE
o PP	POWER POLE
JP	JOINT POLE W/STREET LIGHT
FR	FIBER ROLLS (SC-5)
CS	STOCKPILE MANAGEMENT (WM-3)
CWM	CONCRETE WASTE MANAGEMENT (WM-8)
GB	GRAVEL BAGS
⊗	SILT FENCE
E/C	ELECTRIC LINE OR CABLE LINE
G	GAS LINE
SS	SANITARY SEWER LINE
SD	STORM DRAIN LINE
W	WATER LINE
OHU	OVERHEAD UTILITY LINE
---	PROPERTY LINE
---	FLOW LINE
---	GRADE BREAK
100	CONTOURS
•••••	FENCE, WOOD
x-x-x-x-x	FENCE
█	RETAINING WALL
█	CRUSHED AGGREGATE
█	AC CONFORM/TAPER GRIND
█	NEW 2" AC/6" AB MIN. PVMT
█	CONCRETE
█	EROSION CONTROL BLANKETS (SS-7)
█	VISQUEEN COVER

KEY

CASQA BMP FACT SHEET TITLE	FACT SHEET NO.
SILT FENCE	(CASQA / CALTRANS)
SILT FENCE	(XX-X / SC-1)

BEST MANAGEMENT PRACTICE/GENERAL NOTES

- BEST MANAGEMENT PRACTICES (BMPs)** AT A MINIMUM, THE FOLLOWING BMPs ARE REQUIRED REGARDLESS OF WEATHER CONDITIONS, AND AS APPLICABLE TO THE CONSTRUCTION ACTIVITIES PLANNED. VERIFY ALL OF THE BELOW MEASURES ARE ADDRESSED ON THE ESCP SUBMITTAL, AS APPLICABLE.
 - WET WEATHER MEASURES** IF POSSIBLE, AVOID LAND-DISTURBING ACTIVITIES DURING THE WET WEATHER SEASON - OCTOBER 15 THROUGH APRIL 15. **OTHERWISE**, EXTRA BMP MATERIALS (FILTERS, FIBER ROLLS, GRAVEL BAGS, MULCH/STRAW, PLASTIC COVERS) SHALL BE KEPT ON-SITE FOR PRE-RAIN INSTALL.
 - EXISTING VEGETATION** PROTECT EXISTING VEGETATION; AVOID REMOVAL AS REQUIRED AND WHEREVER POSSIBLE; INSTALL APPROPRIATE/PROTECTIVE FENCING, PERIMETER CONTROLS PRIOR TO WORK.
 - EROSION AND SEDIMENT CONTROL** AS APPLICABLE, SLOPE AND SOIL STABILIZATION BMPs SHALL BE UTILIZED TO PREVENT SLOPE EROSION AND SOIL MOVEMENT ON-SITE AND OFF-SITE. NO SEDIMENT MAY LEAVE THE SITE, BE DEPOSITED OFF-SITE, OR POLLUTE STORM WATER RUNOFF FROM THE CONSTRUCTION SITE.
 - STOCKPILE MANAGEMENT** ALL STOCKPILES SHALL BE CONTAINED AND COVERED WHEN NOT ACTIVE, AND SECURED AT THE END OF EACH DAY. STOCKPILES SHALL BE SECURELY COVERED OVERNIGHT, AND PRIOR TO, DURING, AND AFTER RAIN EVENTS. NO MATERIAL SHALL LEAVE THE SITE OR MOVE INTO STREET.
 - WASTE MANAGEMENT** ALL CONSTRUCTION WASTE SHALL BE CONTAINED AND SECURELY COVERED ONSITE, INCLUDING TRASH, PAINT, GROUT, CONCRETE, ETC. ANY WASH OUT FACILITY SHALL BE CONTAINED, MAINTAINED AND ITS CONTENTS DISPOSED OF PROPERLY; NO MATERIAL SHALL BE WASHED INTO STREET.
 - VEHICLES AND EQUIPMENT** RESPONSIBLE PARTIES MUST ENSURE ALL VEHICLES AND EQUIPMENT ARE MAINTAINED IN GOOD WORKING ORDER, WILL NOT CAUSE DIRT, MUD, OIL, GREASE, OR FUEL TO BE DISCHARGED OR TRACKED OFF-SITE INTO THE STREET. INACTIVE VEHICLES/EQUIPMENT MUST USE COVER AND/OR DRIP PANS.
 - DRAIN/INLET PROTECTION & PERIMETER CONTROLS** DRAINS/INLETS THAT RECEIVE STORM WATER MUST BE COVERED OR OTHERWISE PROTECTED FROM RECEIVING SEDIMENT, MUD, DIRT, OR ANY DEBRIS, AND INCLUDE GUTTER CONTROLS AND FILTRATION WHERE APPLICABLE IN A MANNER NOT IMPEDING TRAFFIC OR SAFETY. PROPERLY INSTALLED SILT FENCING OR EQUIVALENT LINEAR CONTROL SHALL BE EVIDENT ALONG SITE PERIMETER TO PREVENT MOVEMENT OF SEDIMENT AND DEBRIS OFF-SITE.
 - SWEEPING** ALL IMPERVIOUS SURFACES (DRIVEWAYS, STREETS) SHALL BE PHYSICALLY SWEEPED (NOT WASHED OR HOSED DOWN), AND MAINTAINED FREE OF DEBRIS AND ACCUMULATIONS OF DIRT. NO TRACKING OFF-SITE.
 - DEWATERING** NO DEWATERING IS ALLOWED FROM CONSTRUCTION SITES UNLESS DISCHARGE IS AN EXCEPTION TO THE DISCHARGE PROHIBITION PER CITY CODE CH. 31.5-12(C), EXCEPT AS SPECIFIED FOR ASBS DRAINAGES. ANY PROPOSED DEWATERING MUST BE REVIEWED/CLEARED BY CITY AND APPLICABLE REGULATORY AGENCIES.
 - STORMWATER MIXED WITH NON-STORMWATER SHALL BE MANAGED AS NON-STORM WATER.

SITE SPECIFIC NOTES OR MITIGATION MEASURES

- INSTALL VEGETATION FENCING UPSTREAM OF SENSITIVE WATER BODY


REGULATORY PERMITS

- COASTAL DEVELOPMENT PERMIT, CALIFORNIA COASTAL COMMISSION (CDP CCC)
- CONSTRUCTION GENERAL PERMIT, STATE WATER RESOURCE CONTROL BOARD (CGP SWRCB)
- CLEAN WATER ACT SECTION 10, US ARMY CORPS OF ENGINEERS (10 USACE)
- CLEAN WATER ACT SECTION 404, US ARMY CORPS OF ENGINEERS (404 USACE)
- CLEAN WATER ACT SECTION 401, REGIONAL WATER QUALITY CONTROL BOARD (401 RWQCB)
- WASTE DISCHARGE REQUIREMENTS, REGIONAL WATER QUALITY CONTROL BOARD (WDR RWQCB)
- CA FISH/WILDLIFE CODE SECTION 1600, LAKE/STREAMBED ALTERATION AGREEMENT (1600 CDFW)
- OTHER (IDENTIFY) _____

AREA OF SOIL DISTURBANCE: _____ SF OR CY OR AC (SF = SQUARE FOOT, CY = CUBIC YARD, AC = ACRE)

AREA PLAN ALONG RESIDENTIAL STREET

SCALE: 1" = 10'-0"

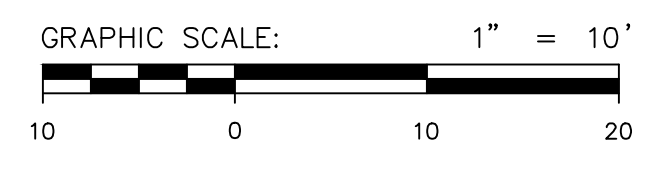

**CITY OF SEASIDE
PUBLIC WORKS DEPARTMENT**

440 HARCOURT AVENUE, SEASIDE 93955
TEL: 831.899.6825 WEBSITE: WWW.SEASIDE.CA.US

DESIGNED BY:	NO.	DATE	REVISION
DRAWN BY:			
CHECKED BY:			
CAD DWG NAME:			
ESCP DRAWING.DWG			

EROSION AND SEDIMENT CONTROL PLAN

123 RESIDENTIAL STREET, SEASIDE, CA 93955

SCALE:	1" = 10'
DATE:	APR 28, 2016
SHEET:	1
	SHEET 1 OF 1